

## **DETAILS**

Location: 58 S. Hallett Street	Summary of Analysis:
	<ul> <li>The placement and size of the proposed new</li> </ul>
Summary of Request:	structure are compatible with other nearby
Construct a new ancillary guesthouse	historic accessory structures.

# Applicant (as applicable):

Paul Davis

### **Property Owner:** Marc Jackson

## **Historic District:** Old Dauphin Way

**Classification:** Contributing

- The proposed structure's size is inferior to the primary dwelling, in accordance with the Guidelines.
- All materials are approvable for new construction and do not impair the historic integrity of the main dwelling.

### **Report Contents:**

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#### PROPERTY AND APPLICATION HISTORY

Old Dauphin Way Historic District was initially listed in the National Register in 1984 under Criterion C for significant architecture and community planning. The district includes most nineteenth-century architectural styles and shows adaptations of middle-class domestic designs of the nineteenth century to the regional, Gulf Coast climate. It includes "fine examples of commercial, institutional, and religious structures as well as 20<sup>th</sup>-century apartments."

The subject property is a one-story frame bungalow with Craftsman detailing. Although the National Register nomination for the Old Dauphin Way Historic District gives the dwelling a construction date of c. 1920, a structure of very similar form appears on the 1904 Sanborn map. The same form is represented on the subsequent 1925 overlay. This form is slightly different from its present configuration. City directories place a Mr. Torrey living at the address in 1900. Given that the house presently features architectural elements such as a deep front porch supported by squared battered columns resting on brick plinths, it can be concluded that the house was constructed between 1895 and 1900 and was then altered to express the popular Craftsman style sometime shortly after 1925.

According to Historic Development Department records, this property has never appeared before the Architectural Review Board (ARB).

### **SCOPE OF WORK**

- 1. Construct a new one-story ancillary guesthouse.
  - a. The prosed structure would be rectangular in shape and would sit on the west end of the lot, orientated to the east, directly behind the main dwelling.
  - b. The proposed structure would measure 22'-4" wide by 31'-4" deep and would be topped by a gable roof with exposed rafter tails. The roof would be clad in asphalt shingles.
  - c. The structure would measure 15'-7" high from finished floor to the ridge vent. Exterior walls would measure 10'-0" to top of plate.
  - d. The foundation would be slab on grade.
  - e. A full-width front porch would span the west façade, supported by four (4) equally spaced round fiber cement wrapped columns, each with cap and base.
  - f. Fenestration would consist of two entry doors and four two-over-two windows.
  - g. Windows would be vinyl clad wood and would measure 3'-0" wide by 5'-0" high.
  - h. The two doors would consist one main entry door on the façade, which would be an eight-pane fiberglass door measuring 3'-0" wide by 7'-0" high. The second door would be located on the west end of the north elevation. This door would be of solid engineered wood and would measure 3'-0" wide by 6'-8" high.
  - i. The exterior walls would be clad in fiber cement lap siding.
  - j. 4" fiber cement trim would surround all doors and windows.
  - k. Fenestration would appear as follows:

#### East façade

One (1) entry door centered on the elevation, flanked by two (2)windows.

#### West elevation

One (1) window centered on the elevation.

#### North elevation

One (1) entry door located at the west end of the elevation.

#### South elevation

One (1) window centered on the elevation.

## APPLICABLE STANDARDS (Design Review Guidelines for Mobile's Historic Districts)


1. **9.1** Design an accessory structure to be subordinate in scale to that of the primary structure.

- If a proposed accessory structure is larger than the size of typical historic accessory structures in the district, break up the mass of the larger structure into smaller modules that reflect traditional accessory structures.
- 2. **9.2** Locate a new accessory structure in line with other visible accessory structures in the district.
  - These are traditionally located at the rear of a lot.
  - fashion that contributes to the traditional rhythm of the district as seen in nearby historic buildings.
  - Incorporate a door casement and trim similar to those seen on nearby historic buildings.
  - Place and size a special feature, including a transom, sidelight or decorative framing element, to complement those seen in nearby historic buildings.
  - Use a door material that blends well with surrounding historic buildings. Wood is preferred. Paneled doors with or without glass are generally appropriate.

### **STAFF ANALYSIS**

58 S. Hallett Street is a contributing property in the Old Dauphin Way Historic District. The application under review seeks approval to construct a one-story guesthouse structure at the property.

The proposed new structure would sit at the rear of the lot, behind the main historic dwelling, which would limit its visibility from the street, and would be in keeping with the location of most historic accessory structures in the immediate vicinity. The approximately 700sf structure with a total height of 15'-7" is considerably inferior to the primary dwelling. Its placement and size align with the guidelines for accessory structures. Additionally, all materials are approvable under the guidelines for new construction, and do not impair the historic integrity of the primary historic dwelling. (9.1, 9.2)

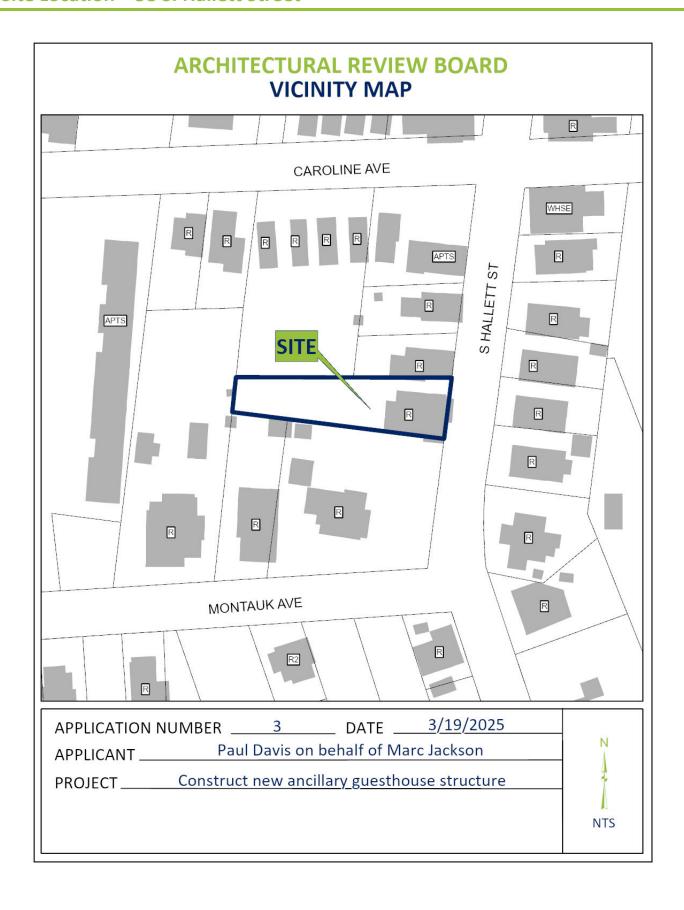



1. View of property, looking W.



3. View of rear of lot, looking NW.




5. View of west end of lot (location of proposed guesthouse, looking W.




2. View of south elevation, looking NW.



4. View of rear yard, looking NW.

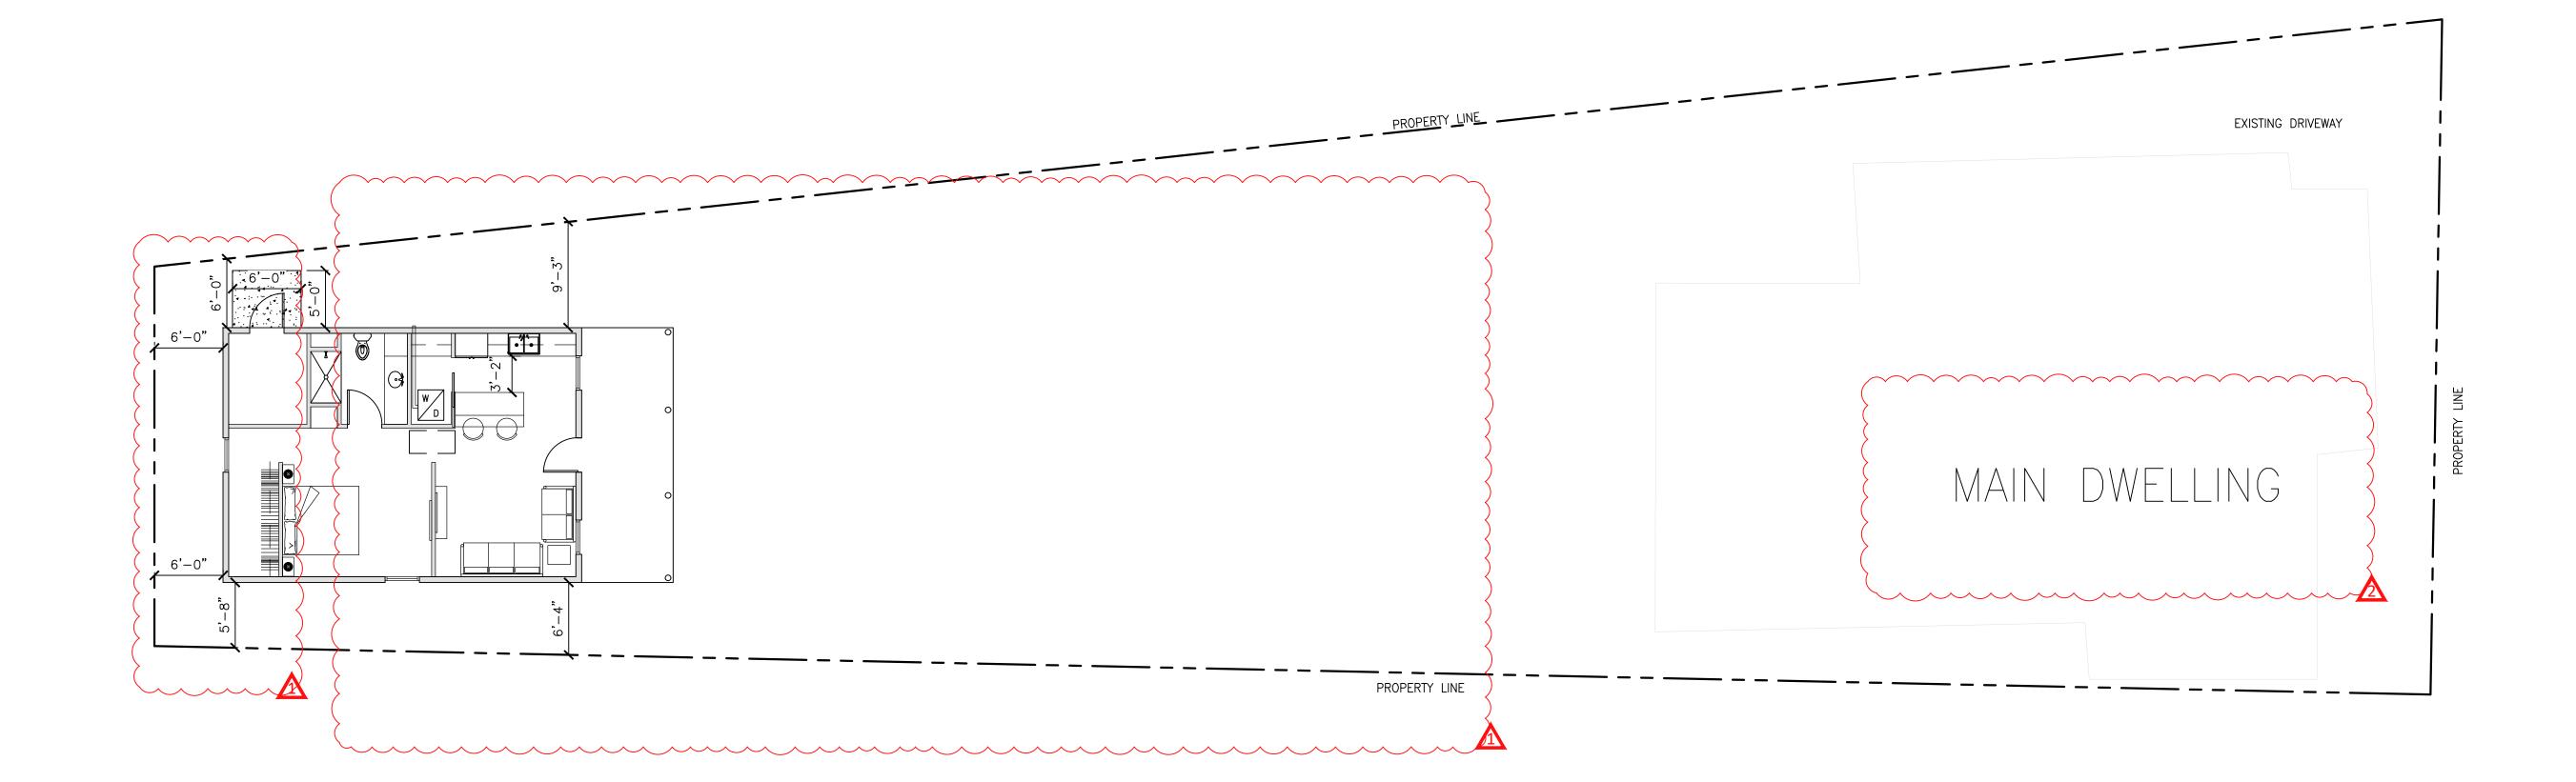

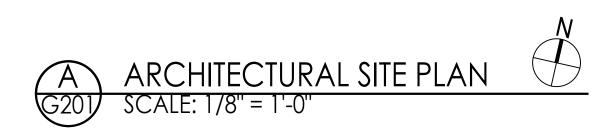



756 Saint Louis Street Mobile, Alabama 36602 (251) 432-3480

> Marc Jackson Guest House 58 SOUTH HALLETT ST MOBILE, AL 36604

APPR	CHK ENGR APPR	CHK	DESCRIPTION	ВУ	DATE	REV	
PCD		PCD	2 03/11/2025 AMC CITY COMMENTS	AMC	03/11/2025	2	
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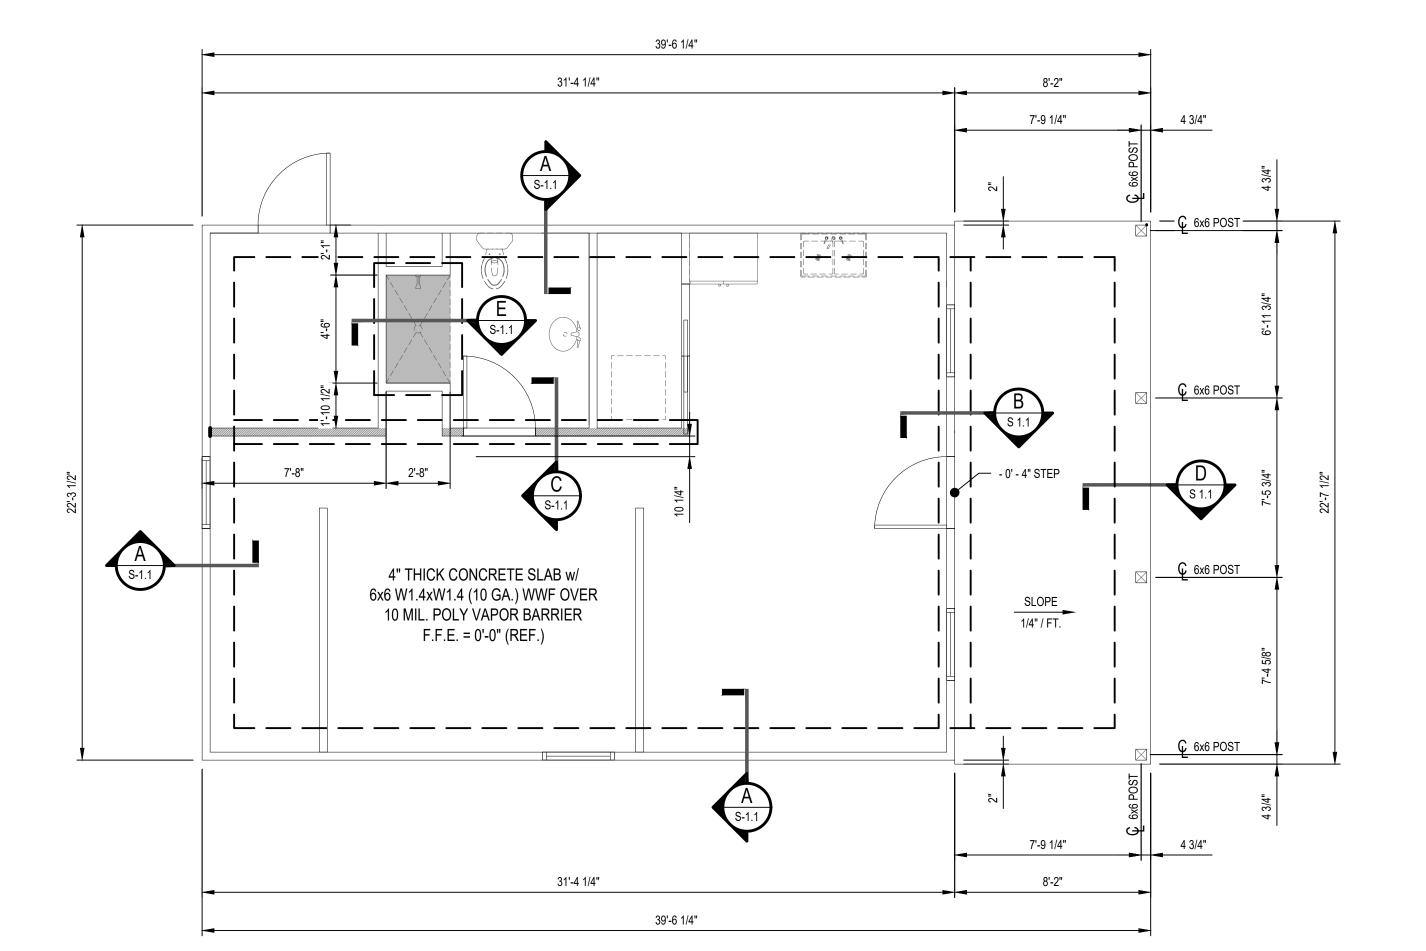
ARCHITECTURAL SITE PLAN

Project Number: 2024-45

Date: OCT 23 2024

Drawn By:
CCC
Checked By:
PCD

Sheet No.




- 1. ALL DIMENSIONS ARE TAKEN TO FACE OF STUD.
- 2. ALL EXTERIOR PORCH POSTS SHALL BE PT 6x6 POSTS U.N.O.
- FACE OF PORCH FOUNDATION DOES NOT ALIGN WITH FACE OF HOUSE FRAMING, DUE TO THE 2" MIN. SIDE CLEARANCE AS REQUIRED BY SIMPSON STRONG TIE IN RELATION TO THE ABU POST BASE. IT SHALL BE THE RESPONSIBILITY OF THE CONTRACTOR TO ENSURE THAT BUMPING OUT THE PORCH FOUNDATION DOES NOT ENCROACH ON A SETBACK LINE.



LEGEND: INTERIOR LOAD-BEARING WALL RECESSED SLAB


B/E ENGINEERING CB, LLC

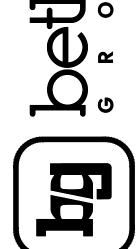

DRAWN BY: CHECKED BY: SSUE DATE: 09-30-2024


SHEET TITLE & NUMBER: **FOUNDATION PLAN** 

S-1.0

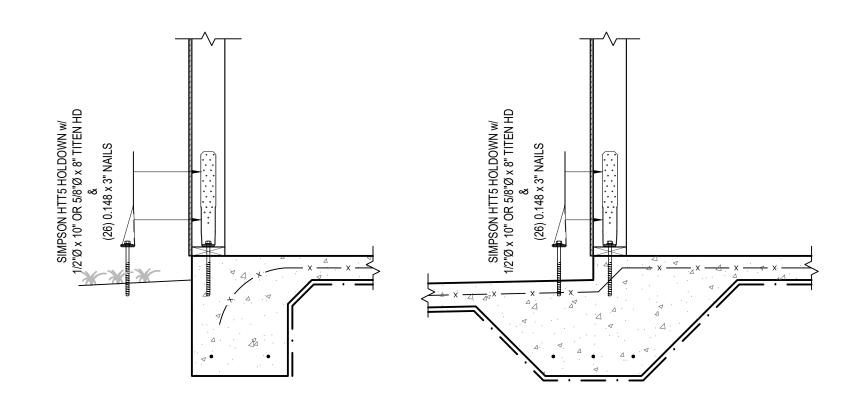


A SIMPSON HTT5 HOLDOWN DETAIL


SCALE: 3/4" = 1'-0"

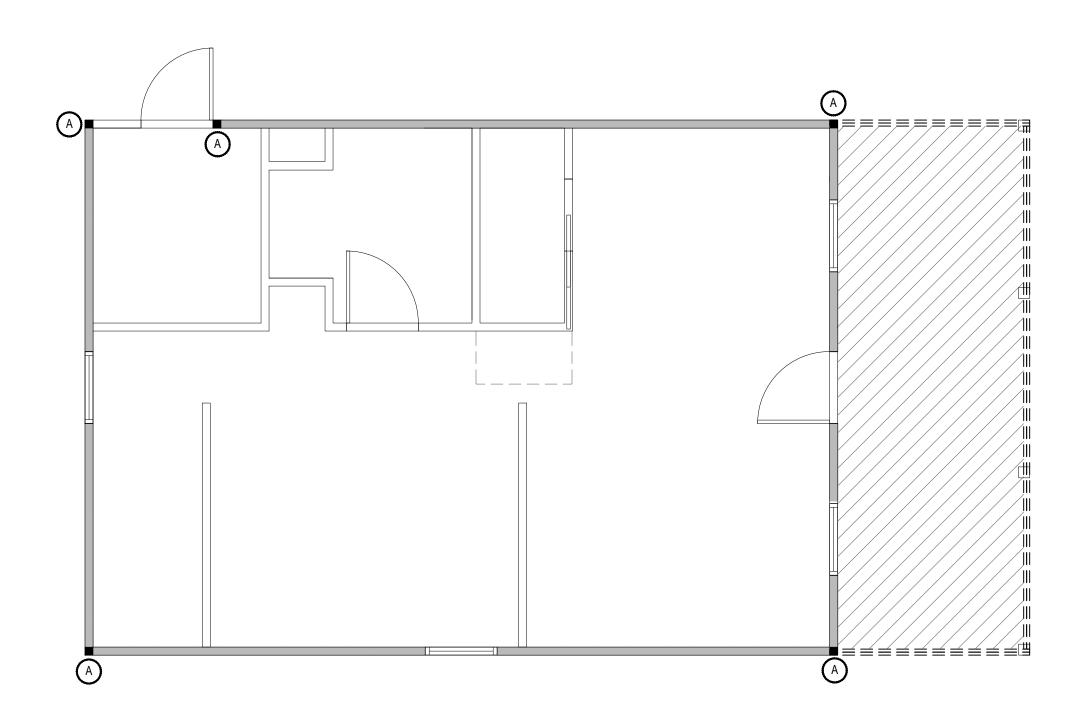

# NOTES:

- 1. ALL EXTERIOR WALLS SHALL HAVE 7/16" NOMINAL APA RATED PLYWOOD OR OSB SHEATHING WITH 8d RING SHANK NAILS AT 4" O.C. EDGE AND 6" O.C. FIELD SPACING.
- 2. ONLY THE EXTERIOR FACE OF WALLS SHALL BE SHEATHED U.N.O.
- 3. ALL PORCH CEILINGS SHALL HAVE 7/16" NOMINAL APA RATED PLYWOOD OR OSB SHEATHING WITH 8d RING SHANK NAILS AT 4" O.C. EDGE AND 12" O.C. FIELD SPACING.

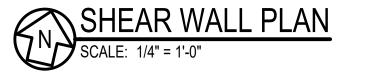

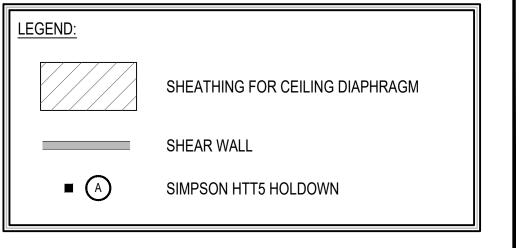

B/E ENGINEERING CB, LLC
3233 Executive Park Cir.
Mobile, Al 36606
thebethelaroup.com



PROPOSED NEW CONSTRUCTION FOR

MARCS RESIDENCE

58 SOUTH HALLETT ST

MOBILE, AL 36604

PROJECT NUMBER: CB2408-038
DRAWN BY: JEH
CHECKED BY: VDL

A B

No. 24712

PROFESSIONAL

9/30/24

PROFESSIONAL


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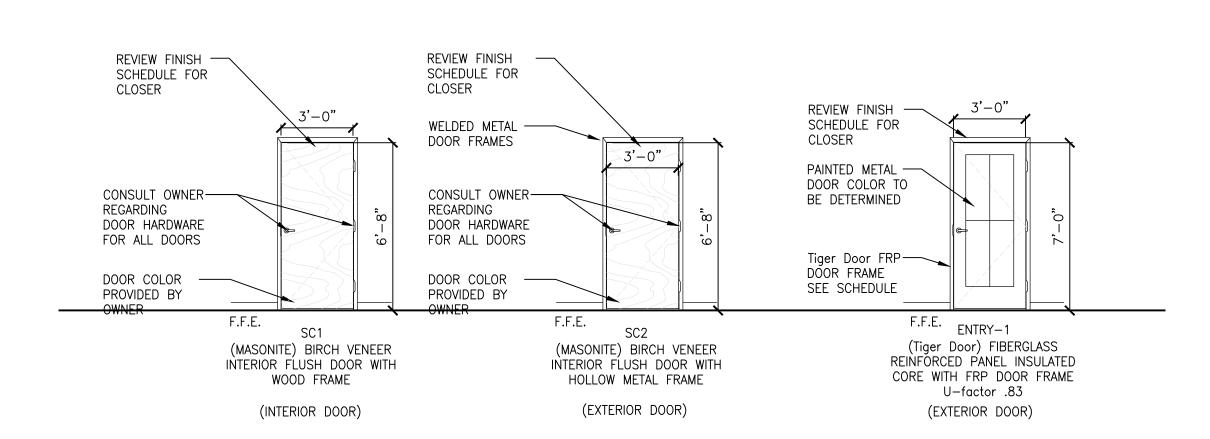
NGINEER

D. LACO

SHEET TITLE & NUMBER:
SHEAR WALL PLAN

S-4.0



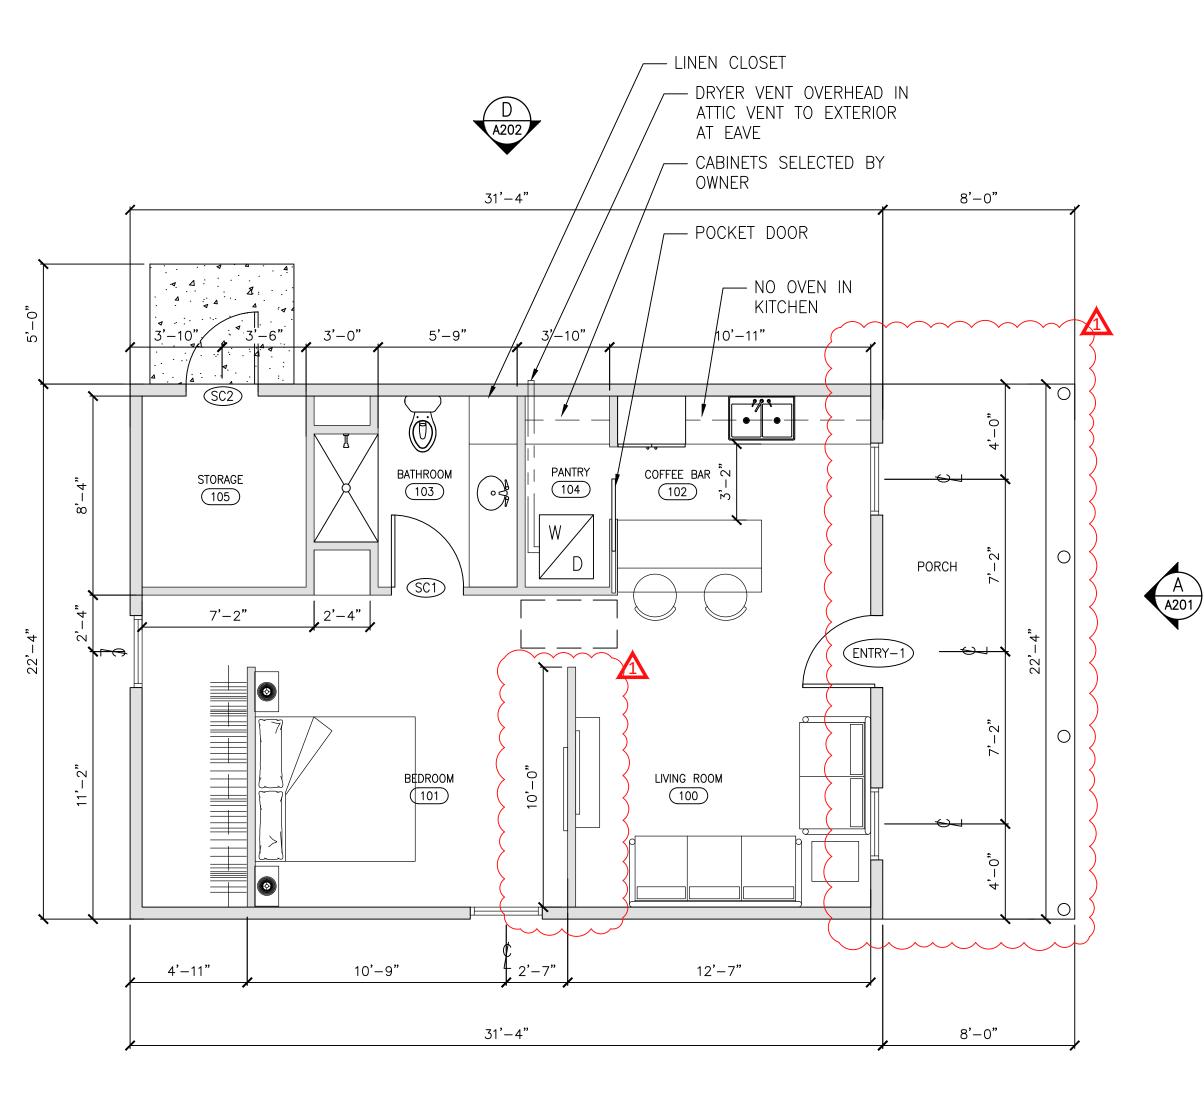

# DOOR DETAILS


NOTE: POCKET DOOR IN PLAN


# FINISHES:

WALLS: GYP. BOARD

BASE: WOOD CEILING: SMOOTH FINISH GYP. BOARD FLOOR: SELECT BY OWNER



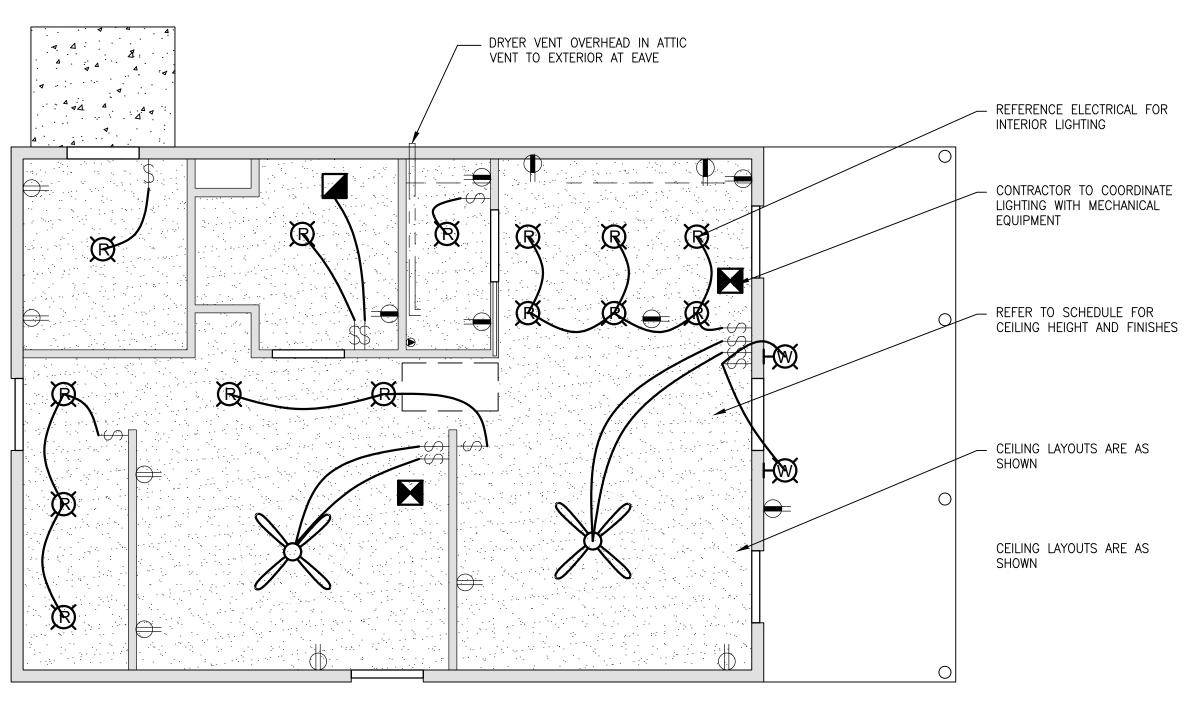

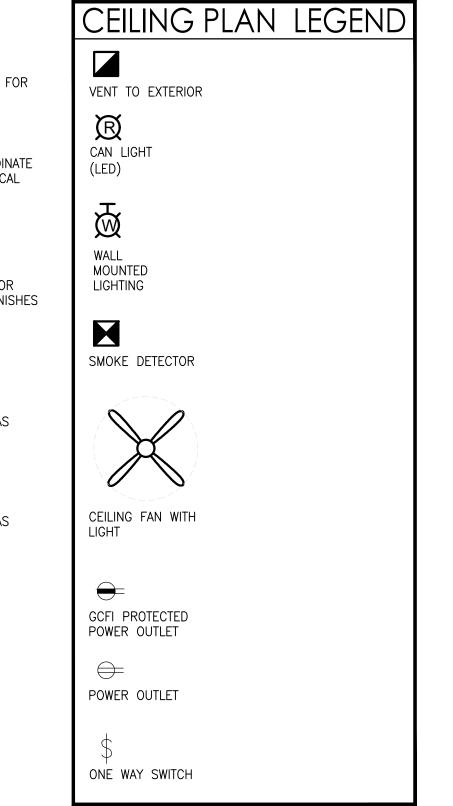



756 Saint Louis Street

Mobile, Alabama 36602

(251) 432-3480

Marc Jackson Guest House 58 SOUTH HALLETT ST MOBILE, AL 36604

APPR	CHK FNGR APPR	ХНО	DESCRIPTION	ВУ	RFV DATE	RFV	
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FLOOR PLAN, CEILING/ELECTRICAL PLAN

Project Number: 2024-45

Date: OCT 23 2024


Drawn By:

PCD

A101

B CEILING PLAN & ELECTRICAL PLAN

A101 SCALE: 1/4" = 1'-0"

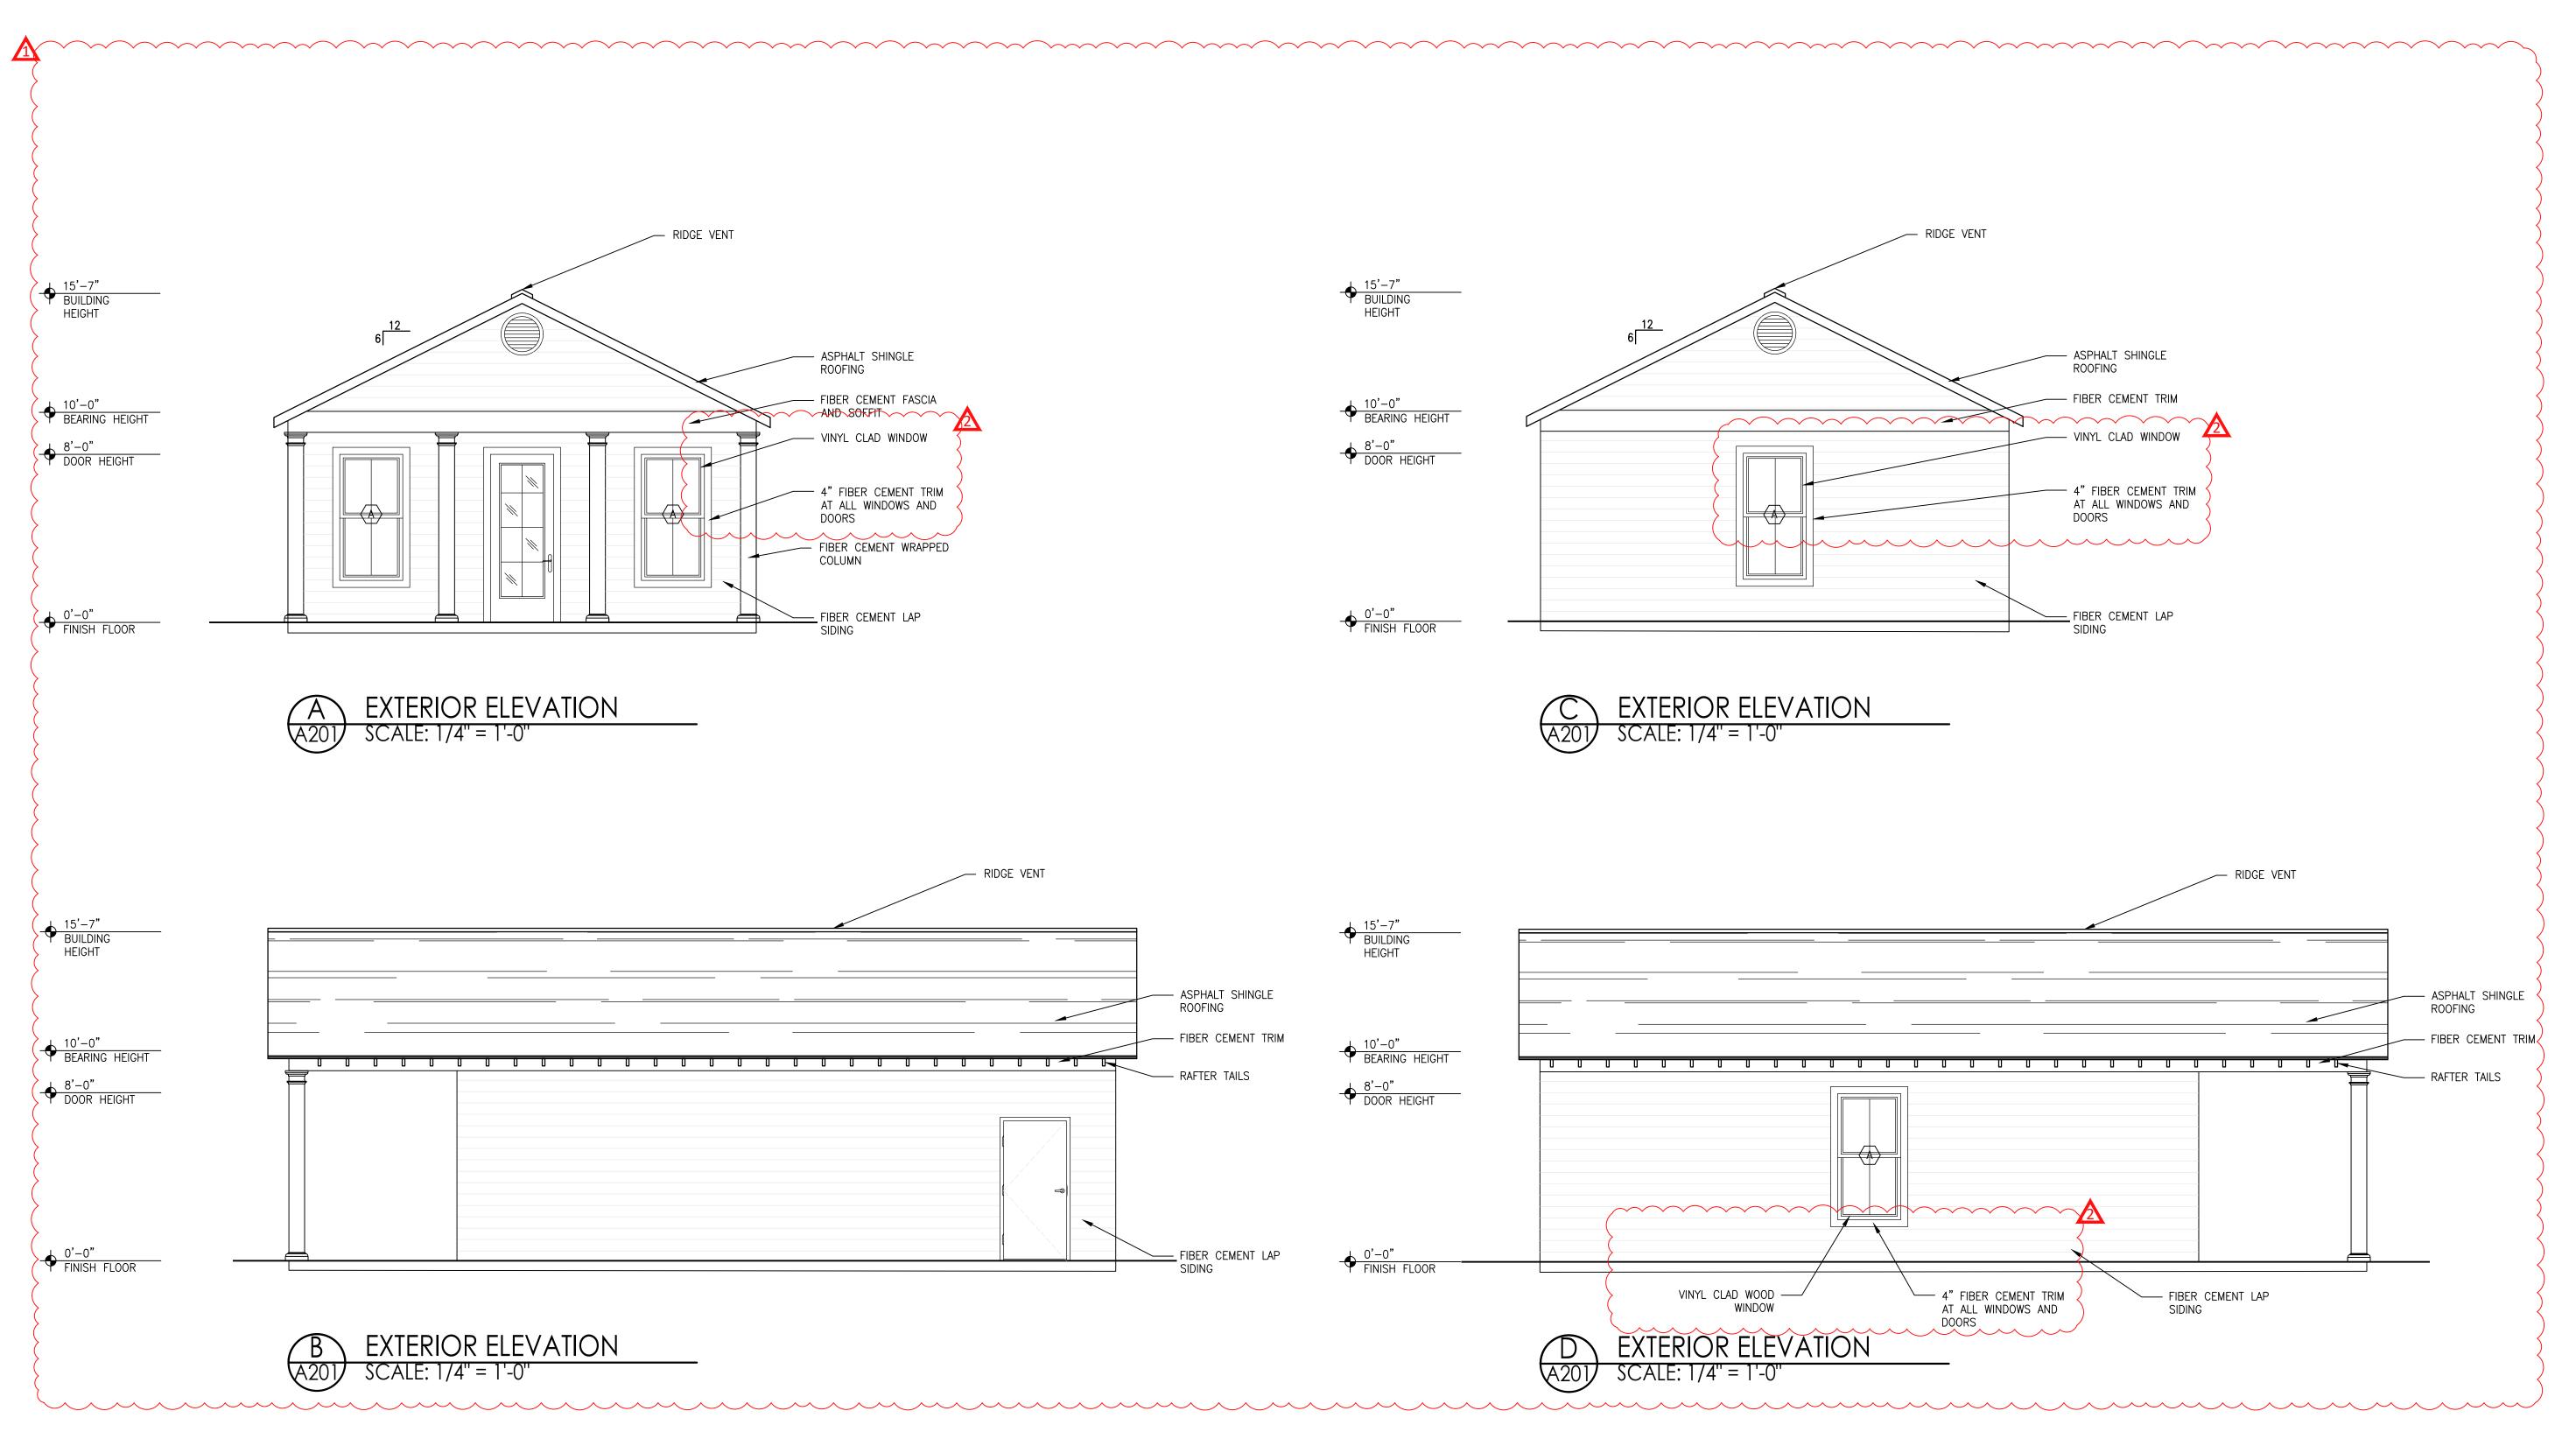

				WINDO	W SCHE	DULE						
WINDOW MARKER	UNIT TYPE	UNIT SIZE WxH	UNIT MATERIAL	UNIT COLOR	MANUFACTURE #	SIDE TRIM	TOP TRIM	SILL	U-FACTOR	SHGC	GLAZING	REMARKS
A	SINGLE HUNG	3'0" x 5'0"	S.B.O.	MATCH EXISTING	S.B.O.	_	_	_	.50	.25	_	PROTECTION PER ASTM E-1996

# WINDOW NOTES


- 1. CONTRACTOR SHALL VERIFY ROUGH OPENING REQUIREMENTS OF ALL OPENINGS PRIOR TO ORDERING WINDOWS ALL BE EQUAL TO THE RATING OF.
- 2. ALL WINDOWS SHALL BE DOUBLED GLAZE REFER TO REMARKS. 3. WINDOW SIZES FOR CUSTOM UNITS ARE APPROXIMATE. CONTRACTOR SHALL DETERMINE ACTUAL SIZE BASED ON FRAMING PRIOR TO ORDERING.
- 4. ALL GLASS SHALL MEET THE AREA LIMITATION REQUIREMENTS IN IBC 2403 5. WINDOWS SHALL BE MANUFACTURES STANDARD SIZES. EXCEPT WHERE NOTED AS CUSTOM.
- 6. CONTRACTOR SHALL NOTIFY ARCHITECT OF CHANGES TO WINDOW SIZES PRIOR TO ORDERING.



Mobile, Alabama 36602 (251) 432-3480

Marc Jackson Guest F 58 SOUTH HALLETT ST MOBILE, AL 36604

7	2 03/11/2025		AMC CITY COMMENTS	PCD		PCD
REV	REV DATE	ВҮ	DESCRIPTION	CHK	CHK ENGR APPR	APPR

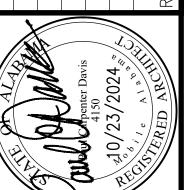



EXTERIOR ELEVATIONS


Project Number: 2024-45


OCT 23 2024

CCC

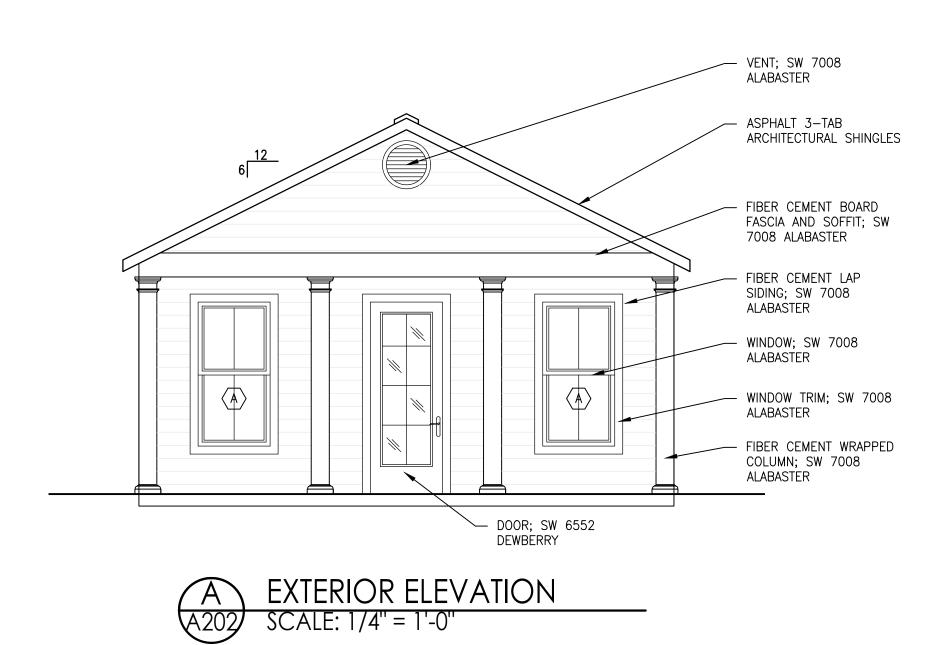


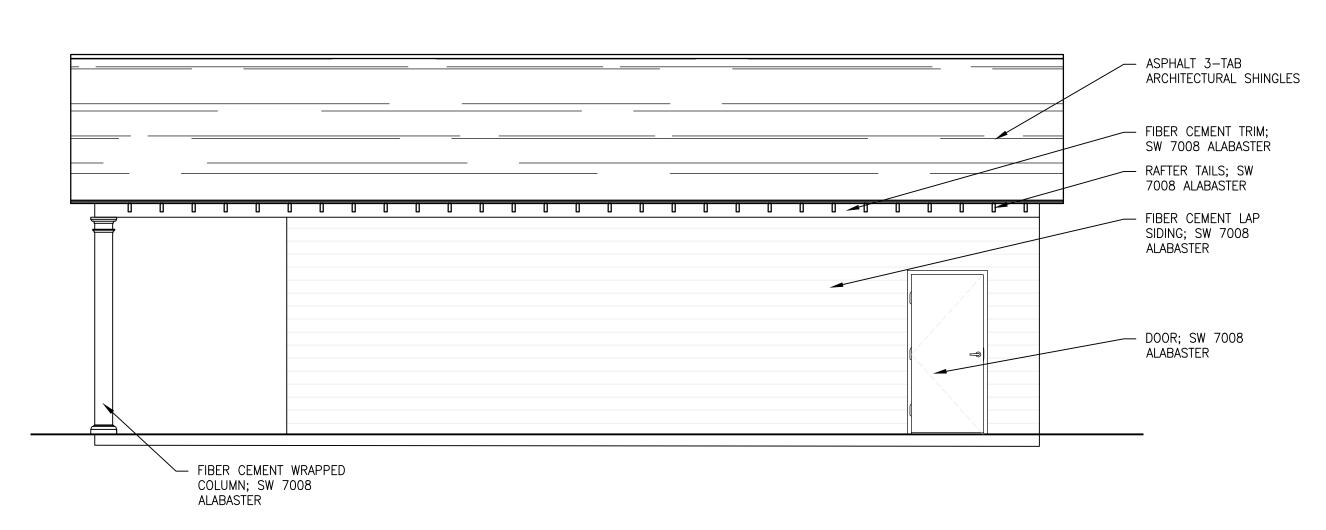

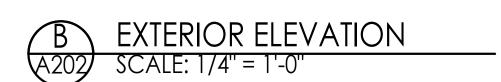

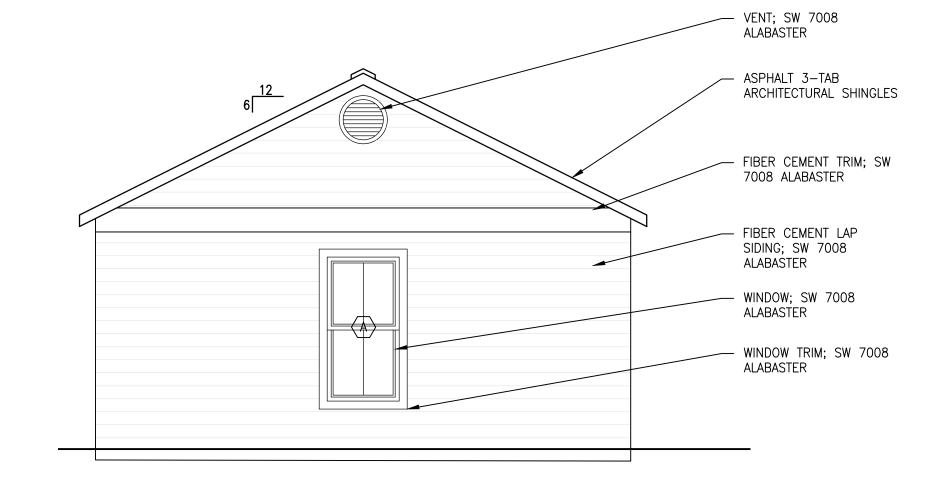



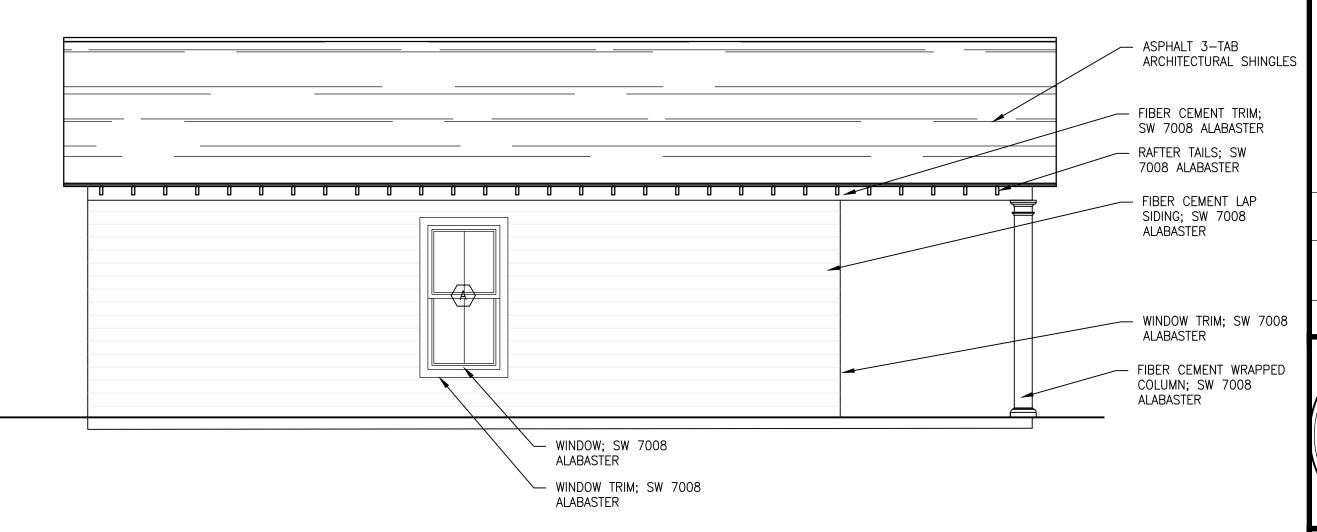

WINDOW SCHEDULE												
WINDOW MARKER	UNIT TYPE	UNIT SIZE WxH	UNIT MATERIAL	UNIT COLOR	MANUFACTURE #	SIDE TRIM	TOP TRIM	SILL	U-FACTOR	SHGC	GLAZING	REMARKS
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PCDA
ARCHITECTURE
756 Saint Louis Street

756 Saint Louis Street

Mobile, Alabama 36602

(251) 432-3480

Marc Jackson Guest House 58 SOUTH HALLETT ST MOBILE, AL 36604

IS DESCRIPTION CHK ENGR APPR



Sheet Title:

EXTERIOR PAINT
PLAN

Project Number:

2024-45

Date:

OCT 23 2024

Drawn By:
CCC

Checked By:
PCD

A202